


LEGEND- PROPOSED- CEILING PLAN	
ABC	ANNOTATION ABBREVIATION. REFER KEYNOTES FOR DESCRIPTION
TYPE HEIGHT	CEILING TAG. REFER CEILING DESCRIPTION BELOW FOR DETAILS. CEILING TAG HEIGHTS SHOWN ARE RELATIVE TO THE ASSOCIATED FFL
Room name	ROOM TAG, NUMBER
	CEILING ACCESS PANEL. FINAL LOCATION ON CEILING TO BE CONFIRMED
	CEILING TILE SETOUT POINT

- NOTES
1. CEILING TILE SETOUT BASED ON 100% FULL SHEETS WITH EQUAL MARGINS TO OPPOSITE SIDES OF EACH ROOM OR AREA
 2. SET OUT SURFACE MOUNTED LIGHT FIXTURES OVER CEILING TILES JOINTS
 3. SET OUT AC GRILLES CENTERED ON CEILING TILES
 4. REFER FINISHES SCHEDULE FOR FINISHES

CEILING TYPES	
EX1	EXISTING PLASTERBOARD CEILING
AT1	600 x 1200mm GRID ACOUSTIC CEILING TILE
AT2	ARMSTRONG ULTIMA CEILING GRID TILE (NRC 0.7 & CAC 40)
CT3	600 x 1200mm STANDARD GRID CEILING TILE (TO MATCH EXISTING CORRIDOR CEILING TILES)
PB1	GYPROCK GYPTONE 12mm SQUARE (16% OPEN AREA) 50mm GLASSWOOL 14KG/M3 ABOVE CEILING (NRC 0.8)
[NO CEILING]	NO CEILING (AS EXISTING)
INSULATION TYPES	
	FIBROUS INSULATION ABOVE CEILING, 75mm MIN. 11KG/M³ (TO CONTROL SOUND INSULATION WHERE PARTITIONS ARE SLAB TO CEILING)

APPROXIMATELY 90 LIGHT FITTINGS TO BE USED IN SPACE FROM NFSA STOCK. TO CONFIRM AND COORDINATE WITH SERVICES CONSULTANTS.

LEGEND - KEYNOTES	
PNT03	PAINT - REFER TO INTERNAL FINISHES SCHEDULE
PNT04	PAINT - REFER TO INTERNAL FINISHES SCHEDULE

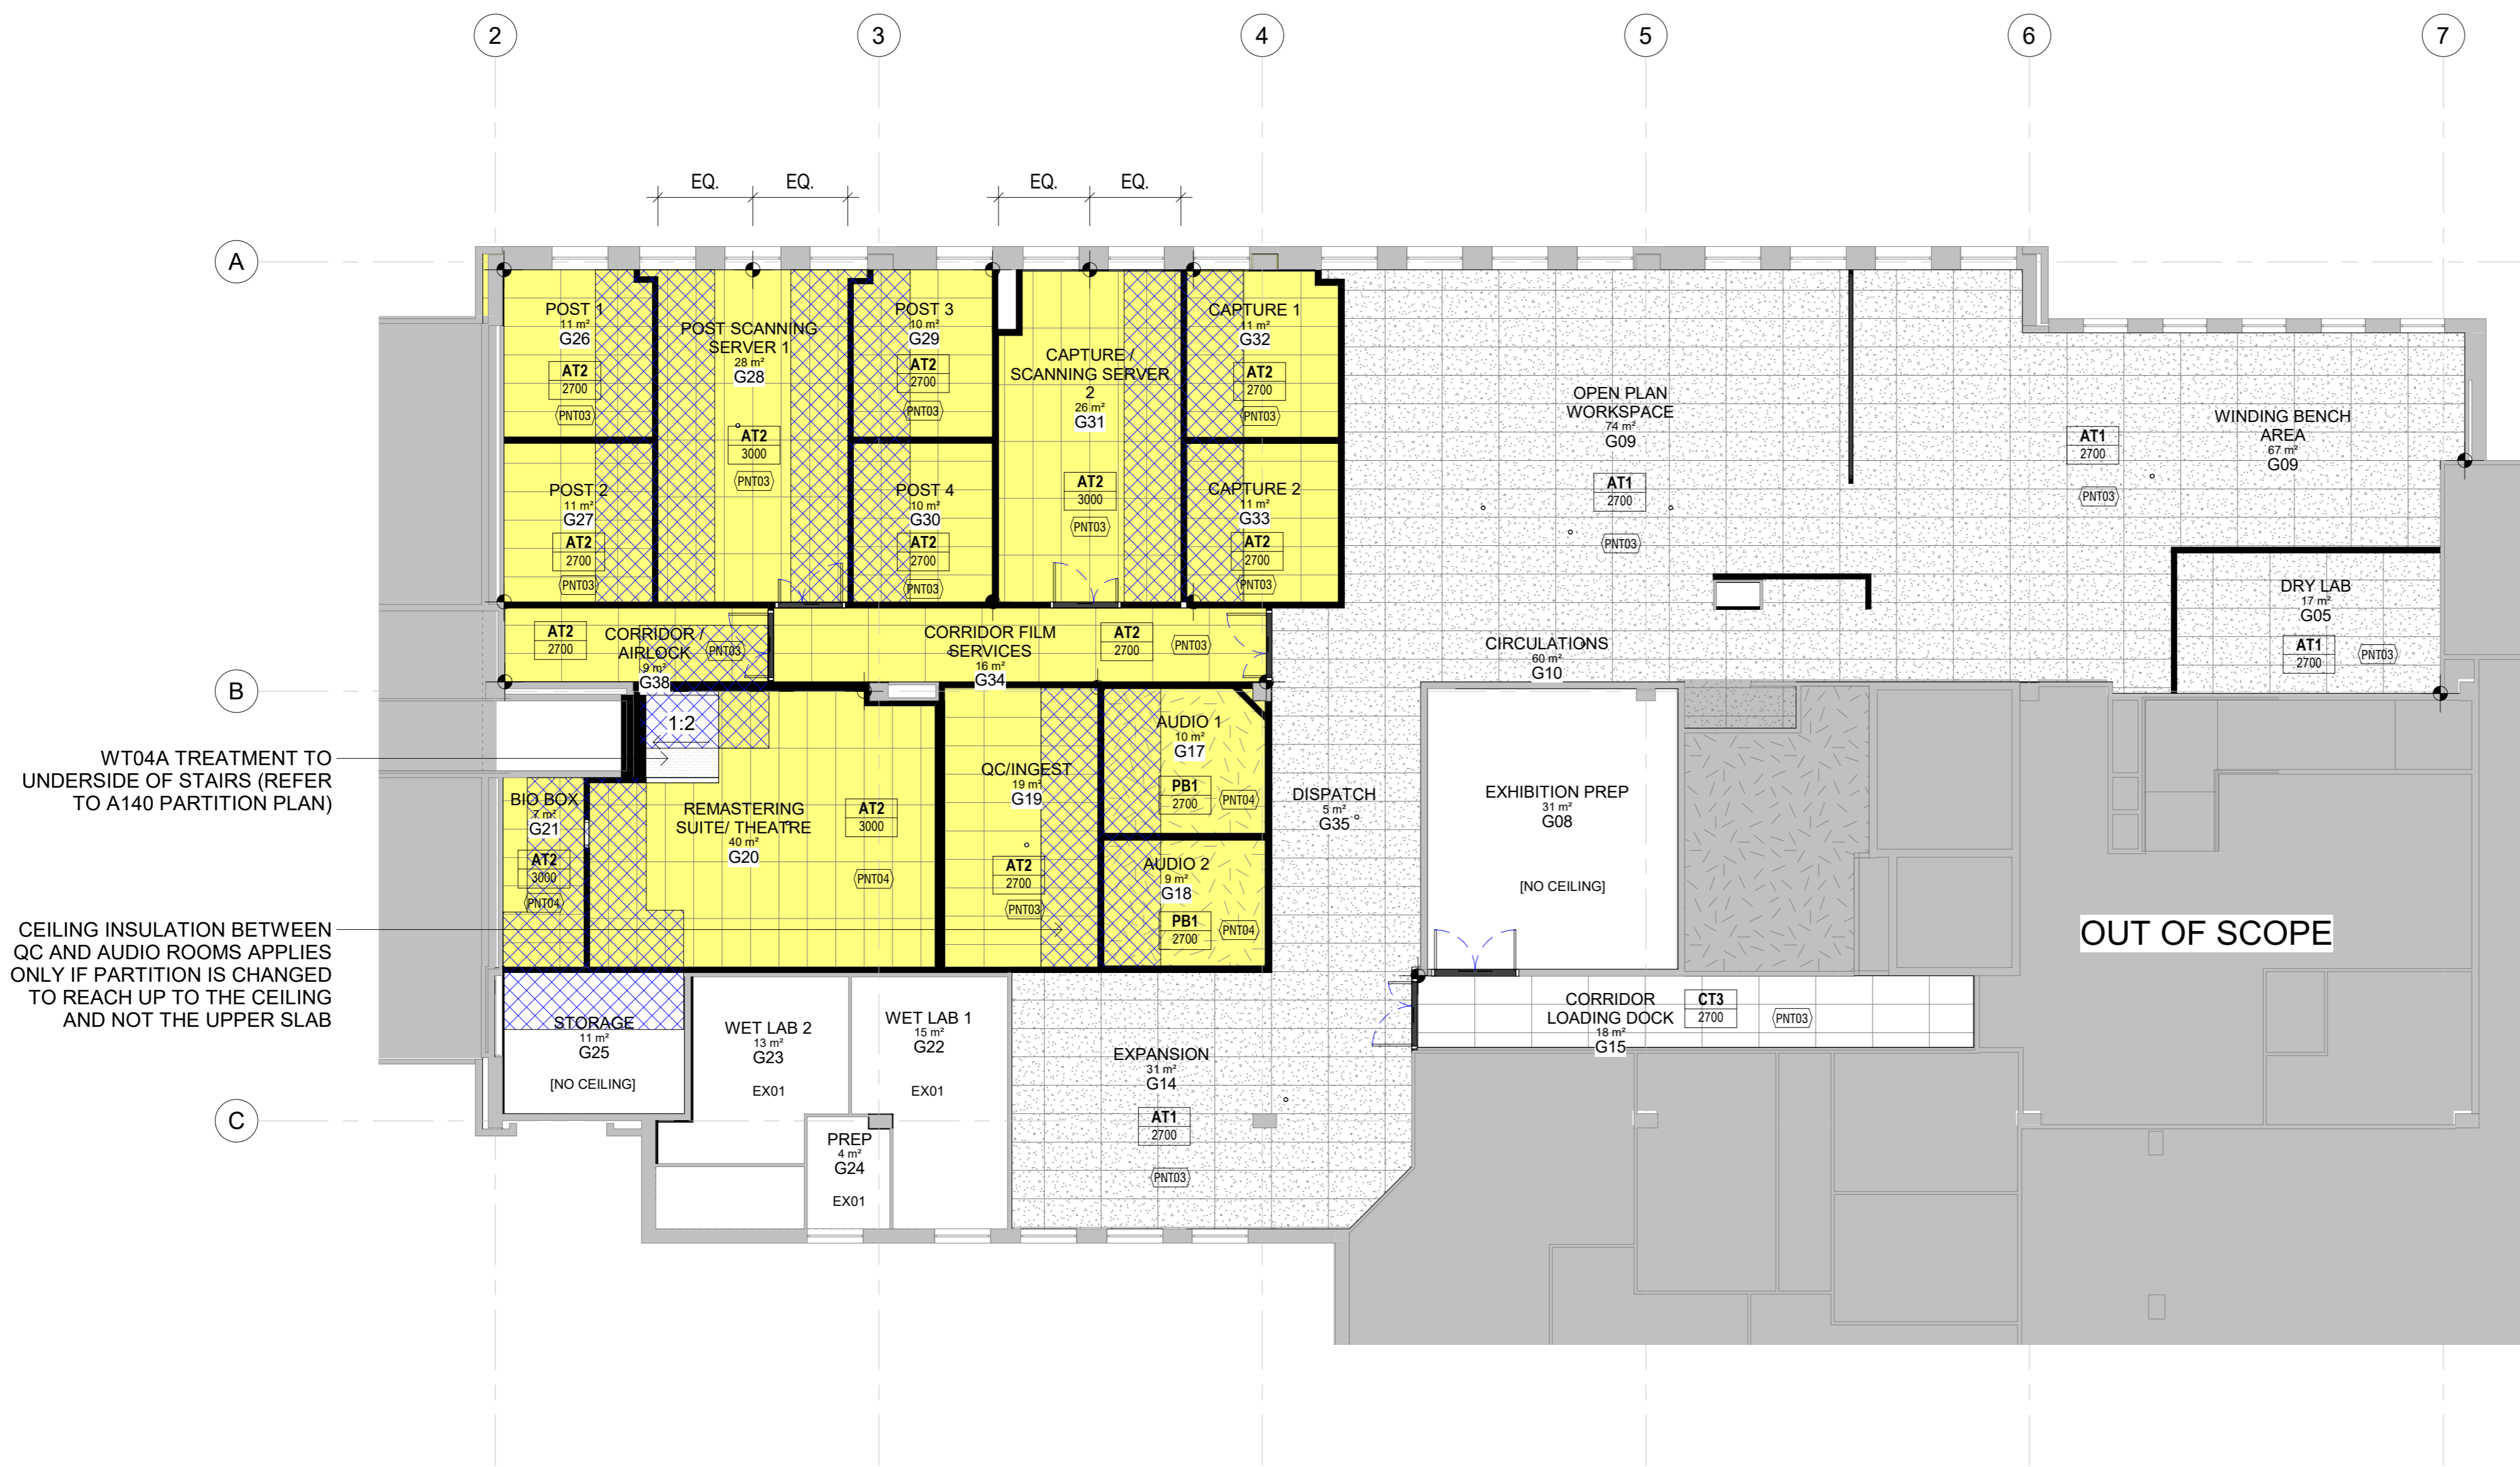

WT04A TREATMENT TO UNDERSIDE OF STAIRS (REFER TO A140 PARTITION PLAN)

CEILING INSULATION BETWEEN QC AND AUDIO ROOMS APPLIES ONLY IF PARTITION IS CHANGED TO REACH UP TO THE CEILING AND NOT THE UPPER SLAB

1 PROPOSED CEILING PLAN
*A230 1 : 100

Revision	Date	Description
A	12.10.22	PSP ISSUE
B	23.12.22	TENDER REVIEW
C	11.01.23	70% TENDER
D	24.01.23	90% TENDER
E	25.01.23	100% TENDER
1	23.03.23	FOR CONSTRUCTION



Client: NATIONAL FILM AND SOUND ARCHIVE OF AUSTRALIA
Project Title: NFSA REFURBISHMENT
B.1 S.21 D.ACTON
20 McCOY CIRCUIT ACTON, ACT 2601

Design Project Manager: KH
Project Delivery leader: DT
Quality Manager: DT
Drawn: CO, JJ, RM

Drawing Title: REFLECTED CEILING PLAN
Scale: 1 : 100
Project: 1870.06
Sheet Size: A1
Drawing: A150
Revision: 1

FOR CONSTRUCTION

SCALE: 1:100 @ ORIGINAL SCALE

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All dimensions in millimetres. Do not scale drawing. All dimensions and levels to be verified on site by contractor before commencing work or preparation of shop drawings, where provide, drawings must be read in conjunction with specification and schedules.

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